Attachment B

Selected Drawings

DEVELOPMENT APPLICATION FOR NEW RESIDENCE AT 8 CONFILL PLACE. FOREST LODGE, NSW 2037

DA 01- Council Compliance

DA 02- Site / Roof Plan & Analysis

DA 03- Demolition and Existing Elevations

DA 04- Proposed Ground Floor Plan

DA 06- Elevations- East & West

DA 05- Proposed First Floor Plan

DA 07- Elevations-North and South

DA 08- Section AA, BB

DA 09- Section CC, DD

DA 10- Shadow Diagram - Winter Solstice 9am

DA 10-1 - Shadow Diagram - Winter Solstice 10am

DA 10-2 - Shadow Diagram - Winter Solstice 11am

DA 11- Shadow Diagram - Winter Solstice 12pm

DA 11-1- Shadow Diagram - Winter Solstice 1pm

DA 11-2- Shadow Diagram - Winter Solstice 2pm

DA 12- Shadow Diagram - Winter Solstice 3pm

DA 13- Photomontage: Front

DA 14- Photomontage: Rear

DA 15- External Finishes Schedule

5m 10m

Paddon Residence 8 Coneill Place, Forest Lodge 2037 Lot 8 DP 24125

dwg title: Cover Page

DA-00 1:100 @A2 project no.: 106 scale: Peter Paddon

client:

date: AUGUST 2022

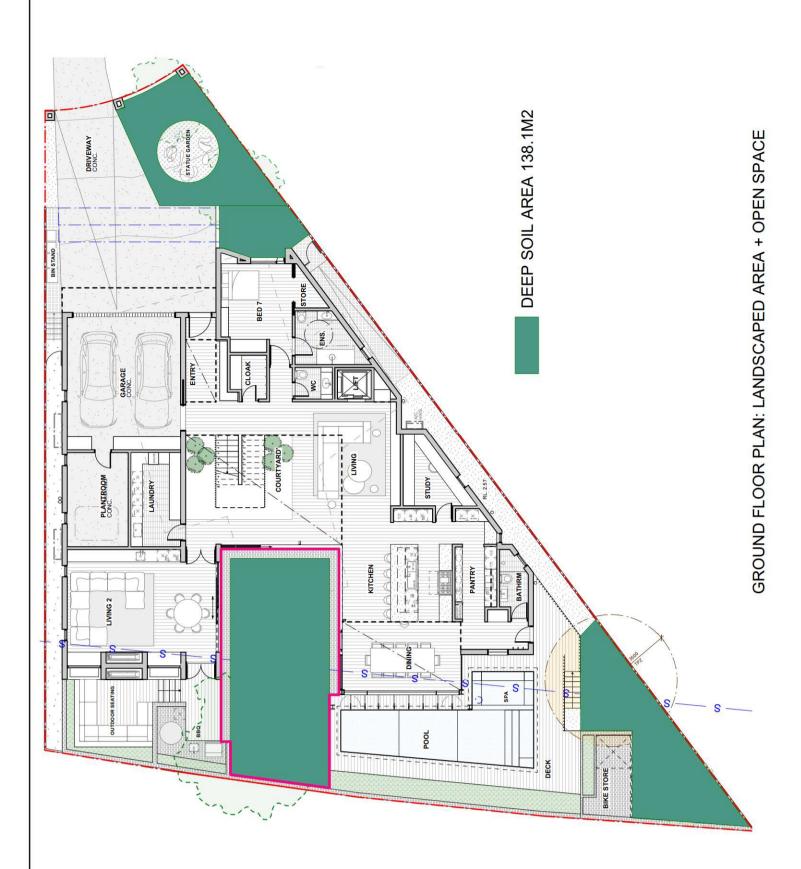
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date 15/03/2023



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LEP /DCP Compliance Summary: Control

Control	Proposal	Compliance Yes / No
Maximum Building Height: 6.0 m Previously Approved Building Height for other New Projects in Coneill Place: 8.5m		No Yes
FSR: 0.70:1 Allowable Gross Floor Area: 581m² (Based on site area of 830m² as surveyed)	Ground Floor GFA = 296.1 m^2 First Floor GFA = 230.4 m^2 Total GFA: 526.5 m^2	Yes
Setbacks: Rear: predominant building lines Front: predominant building lines Side: on merit (BCA min'm 900mm where openings)	Setbacks: Side: South:1.2M North:0.9M Rear: 3.9M - 8.5M Front: 9.25M - 10.7M	Yes Yes Yes
Flood Prone:	Design strategy approved by WMA flood Consultants	Yes
andscaped Area: 15 % Of Site Deep Soil: Required 124.5 M² 16 m sq open space	Total landscaped area ground floor: 138.1 M2 open space main garden: 73.4 m²	Yes
2 car spaces		Yes

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FIRST FLOOR PLAN: GFA

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date 15/03/2023 no. description

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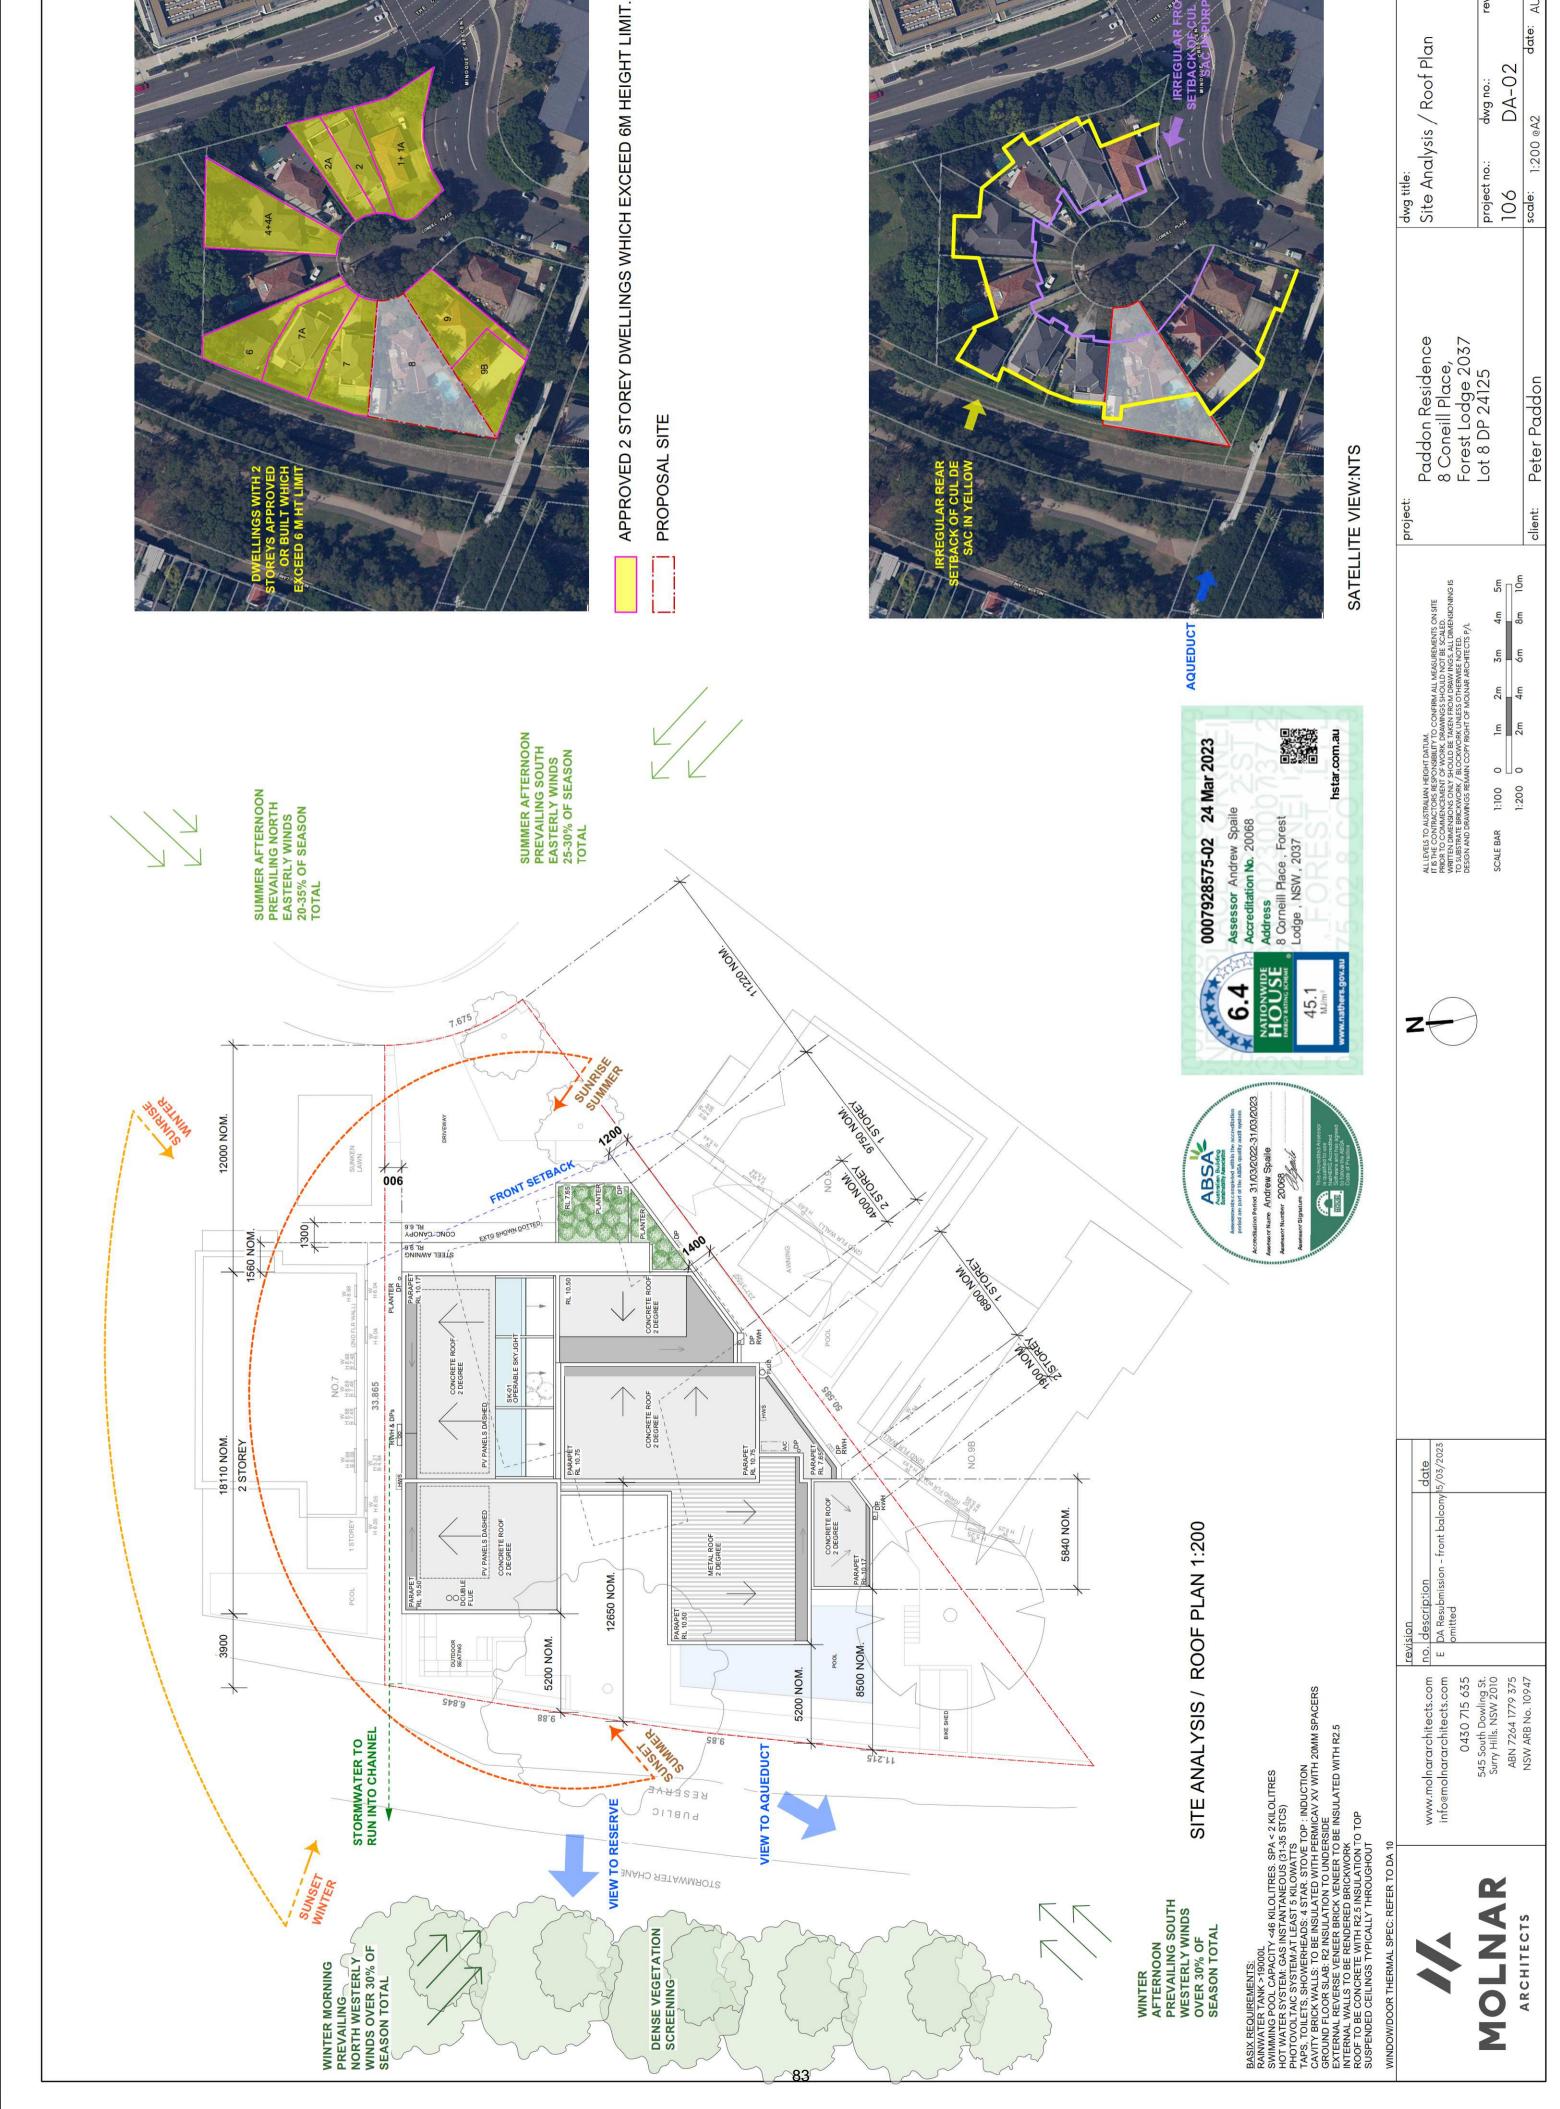
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Paddon Residence 8 Coneill Place, Forest Lodge 2037 Lot 8 DP 24125

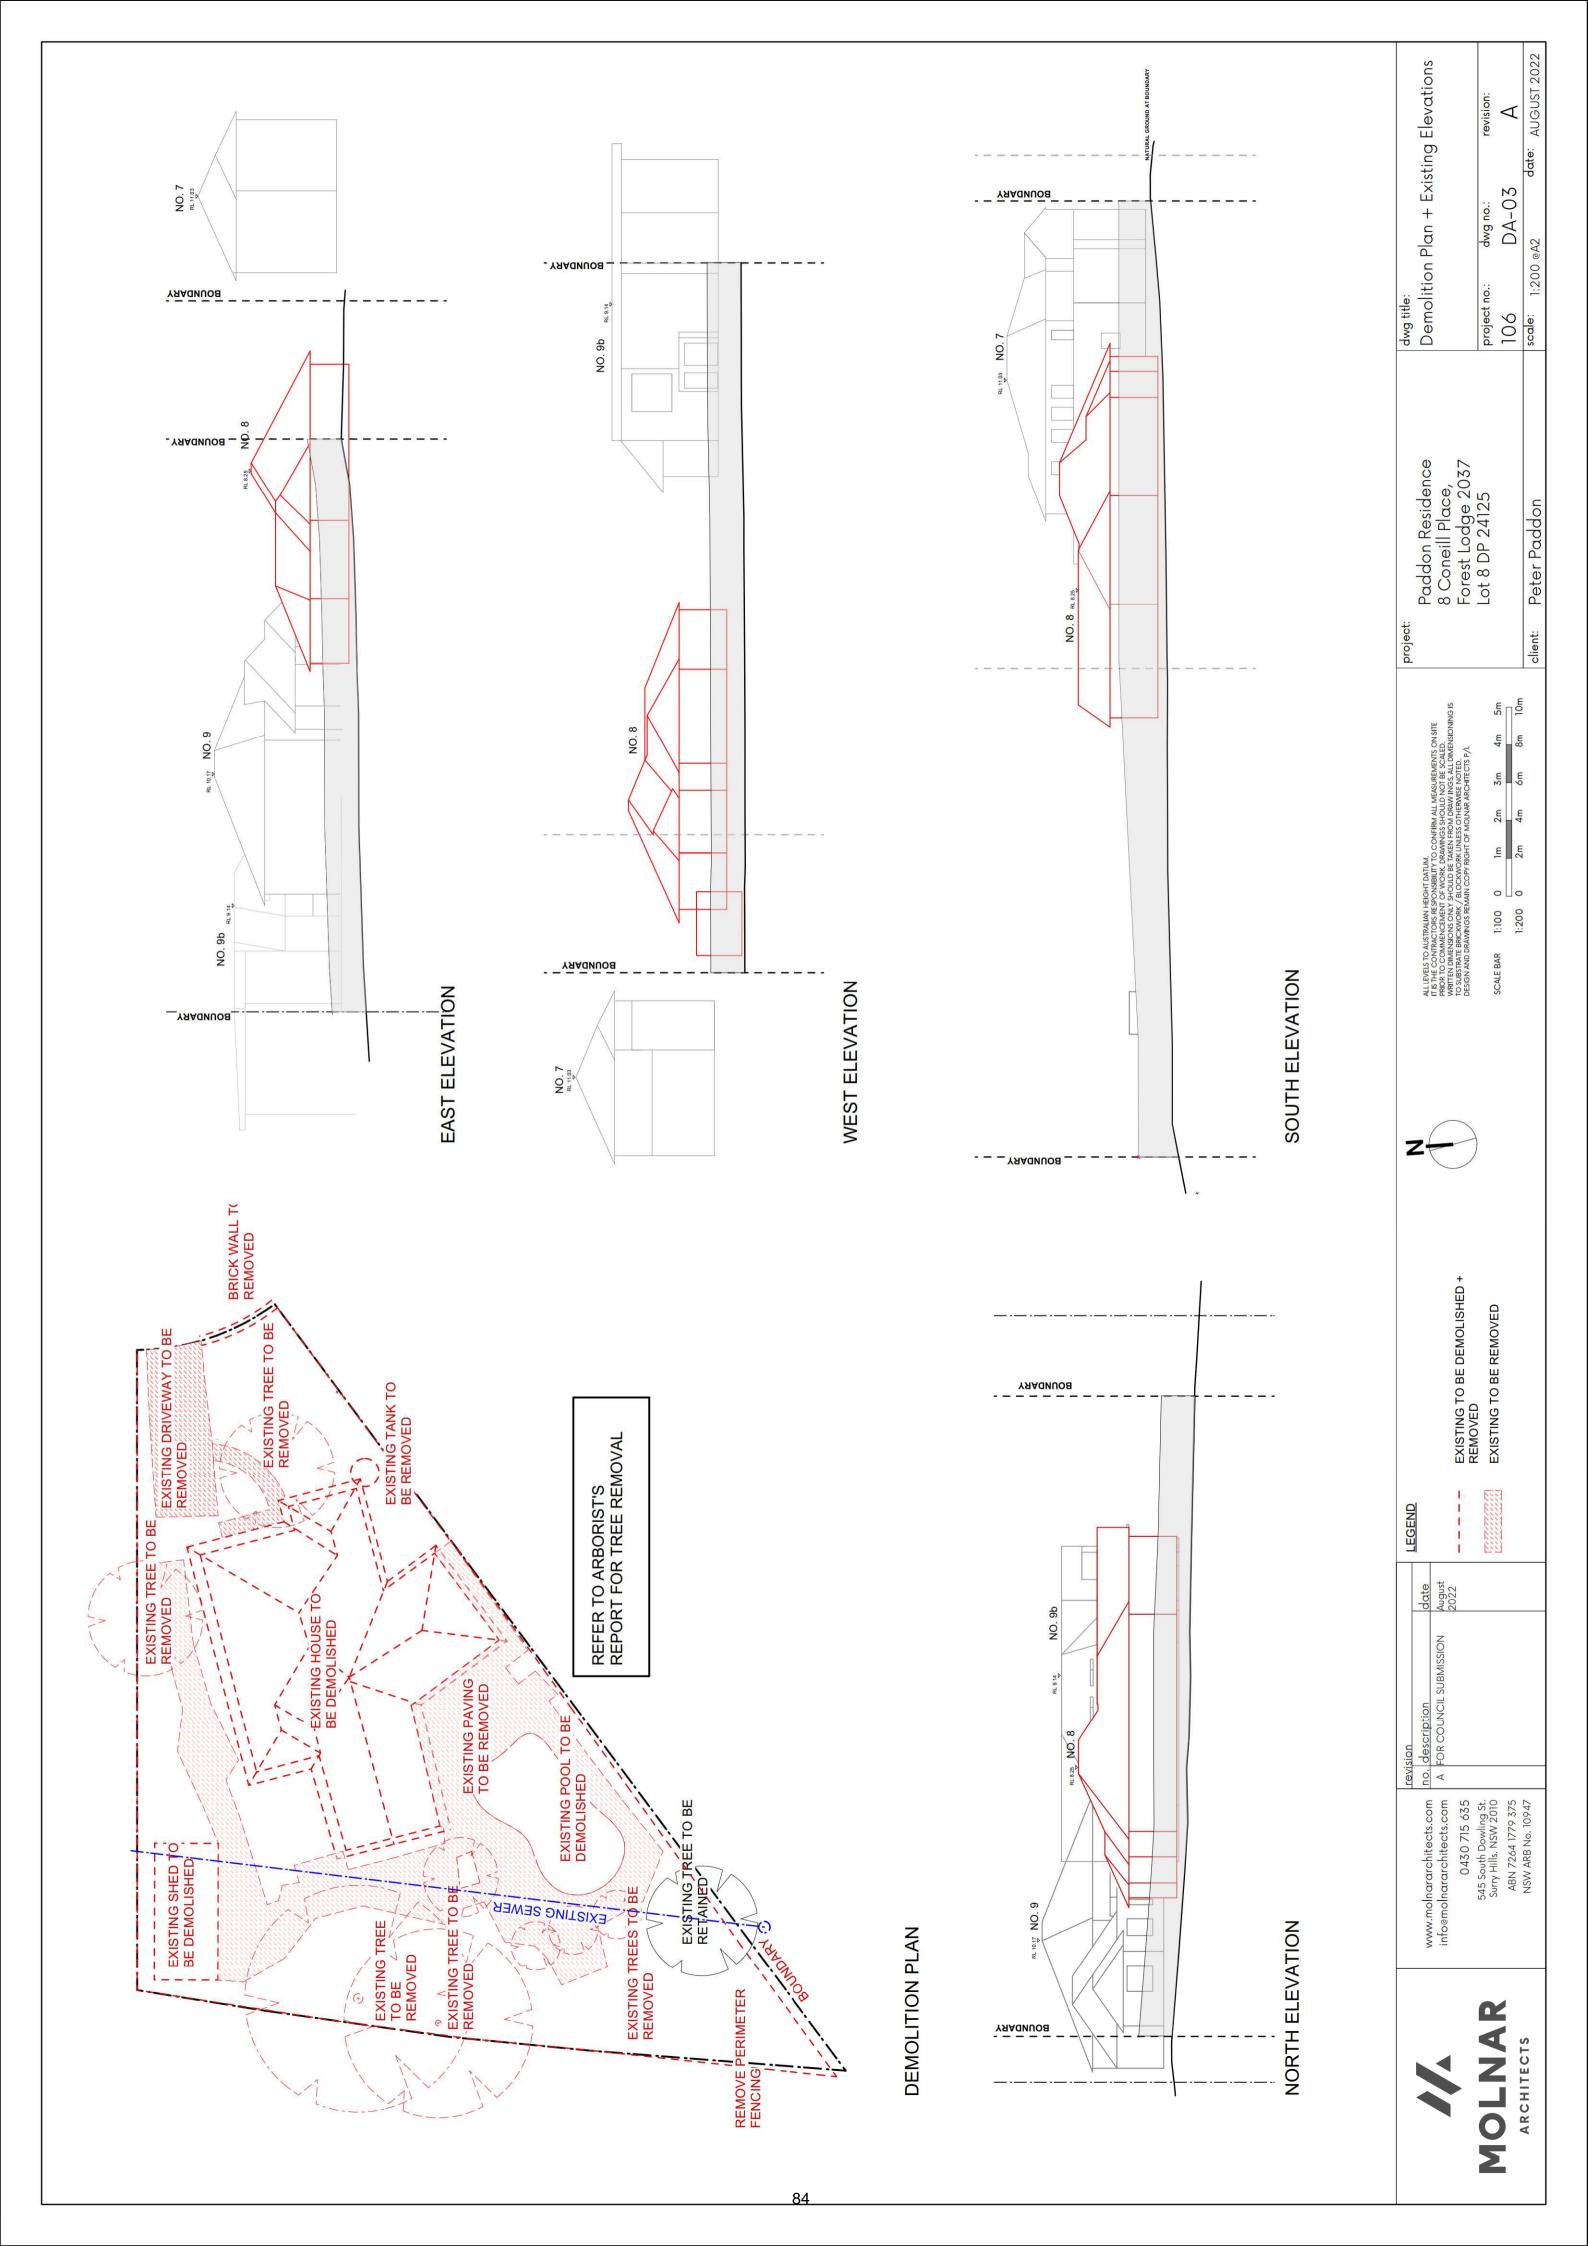
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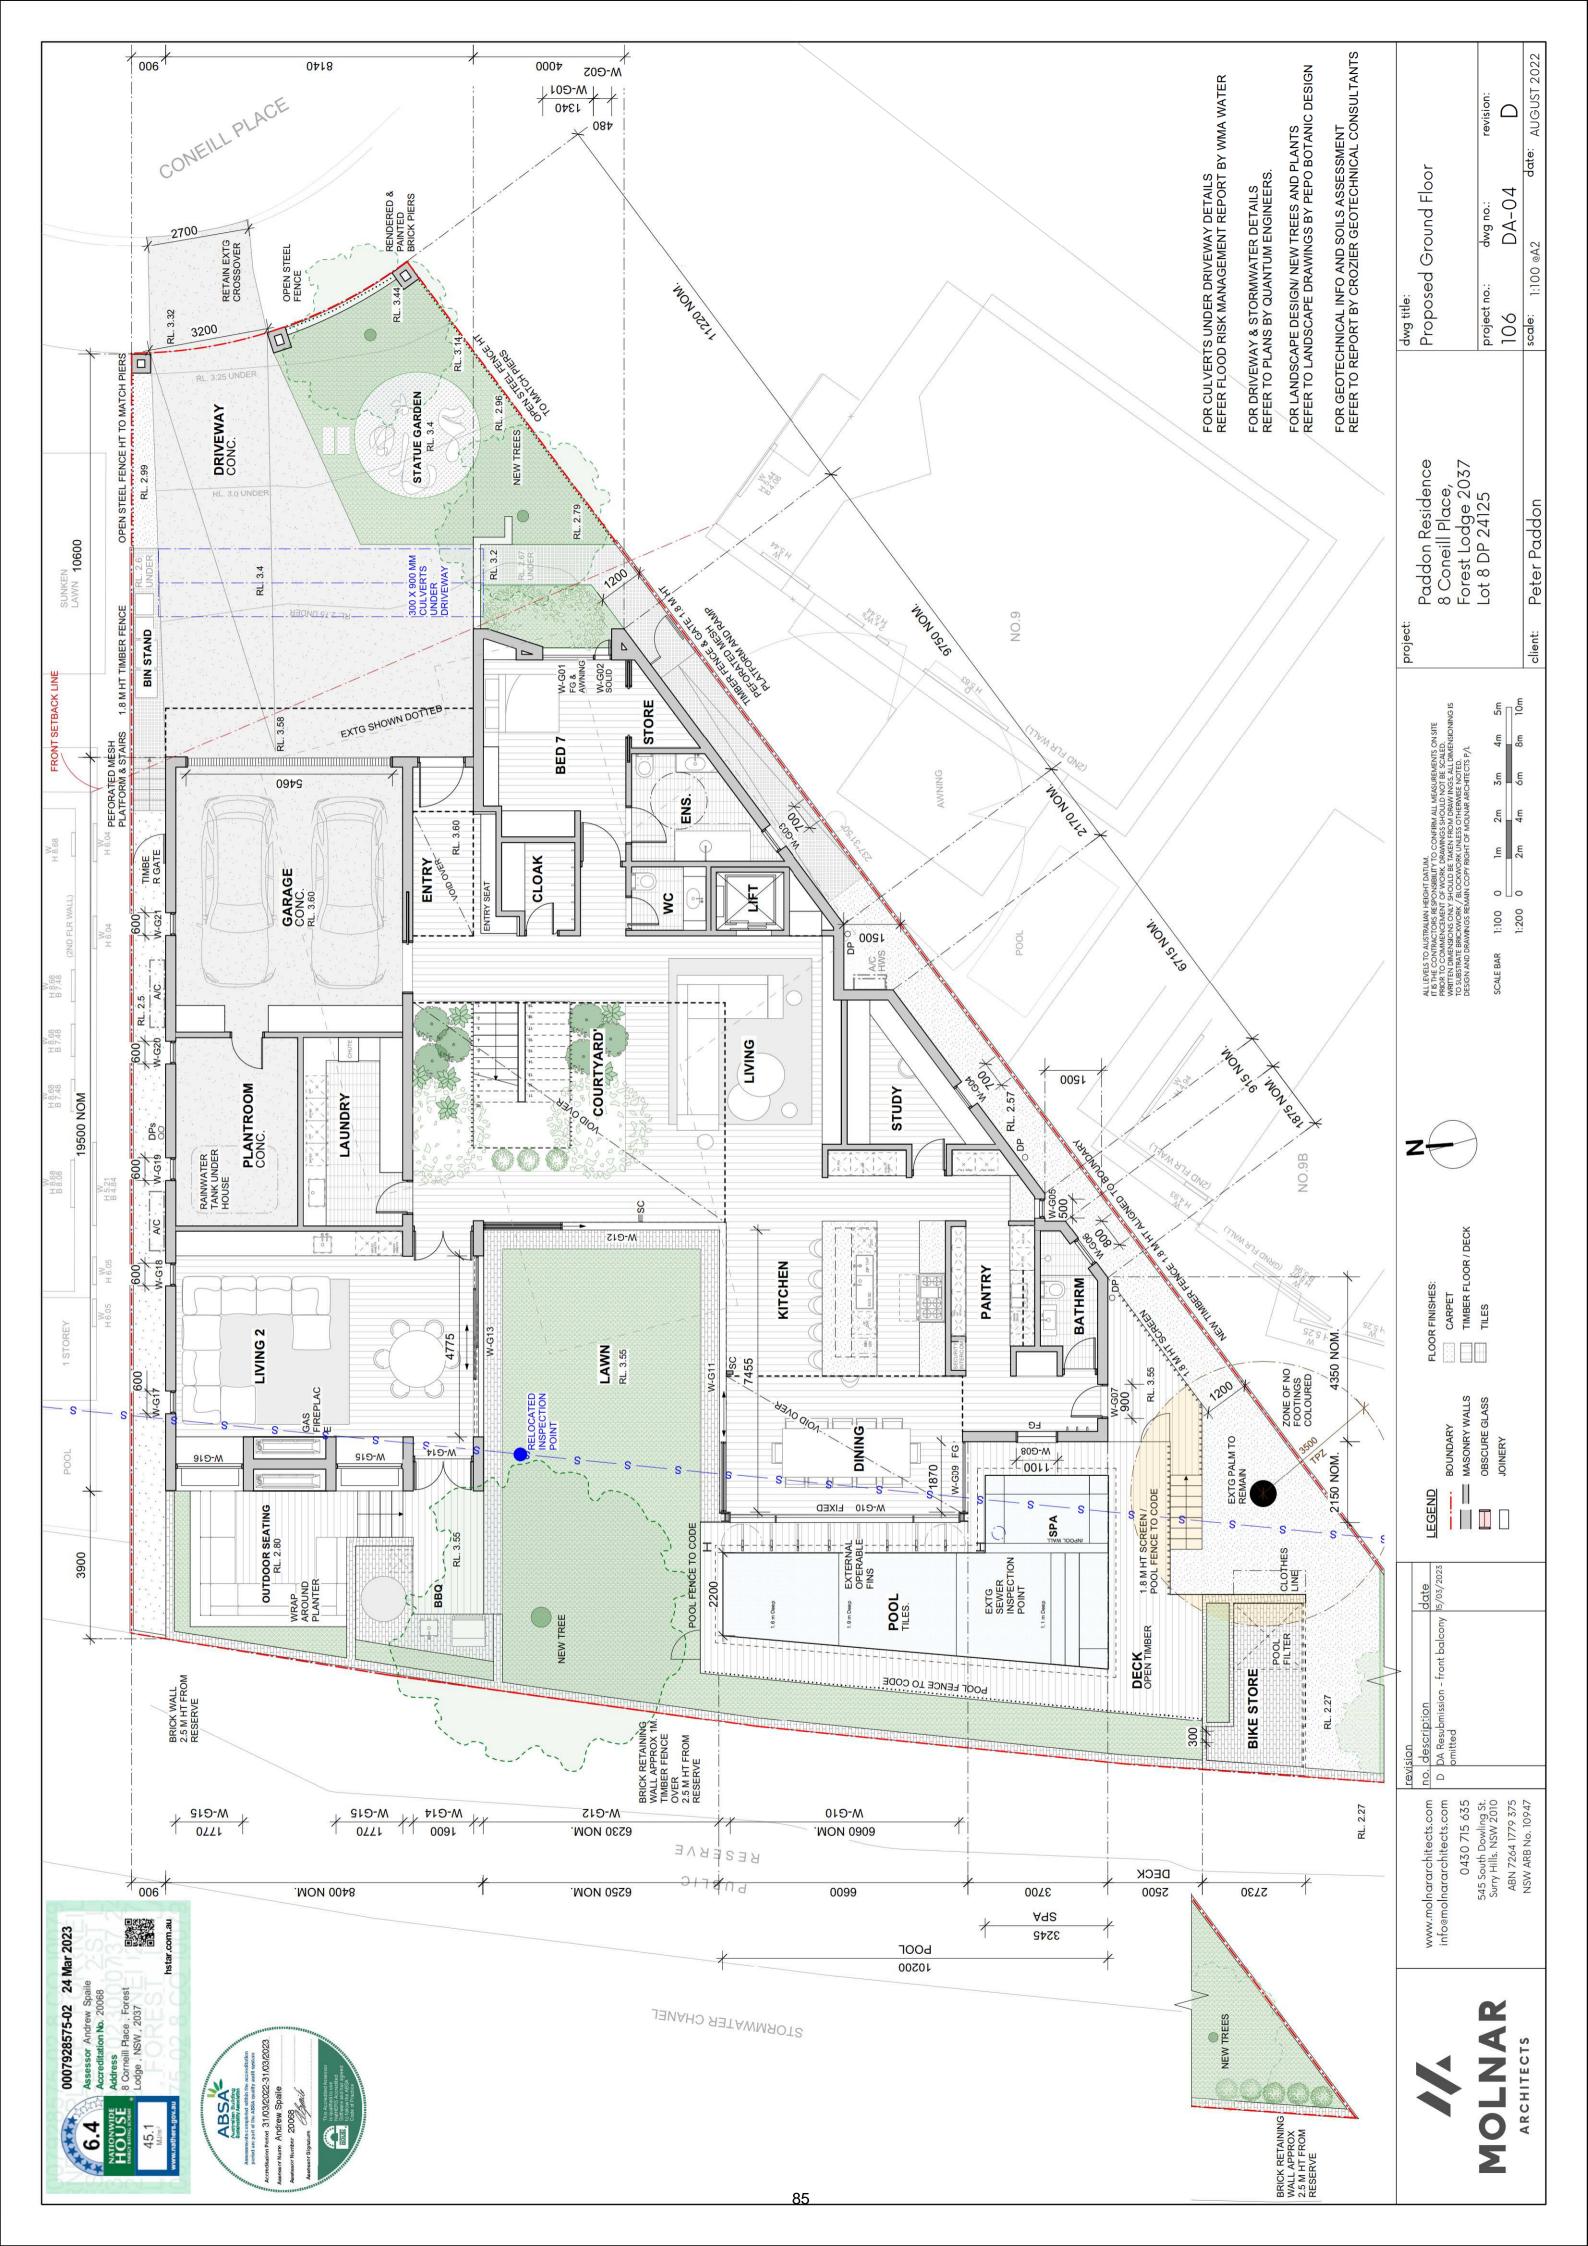
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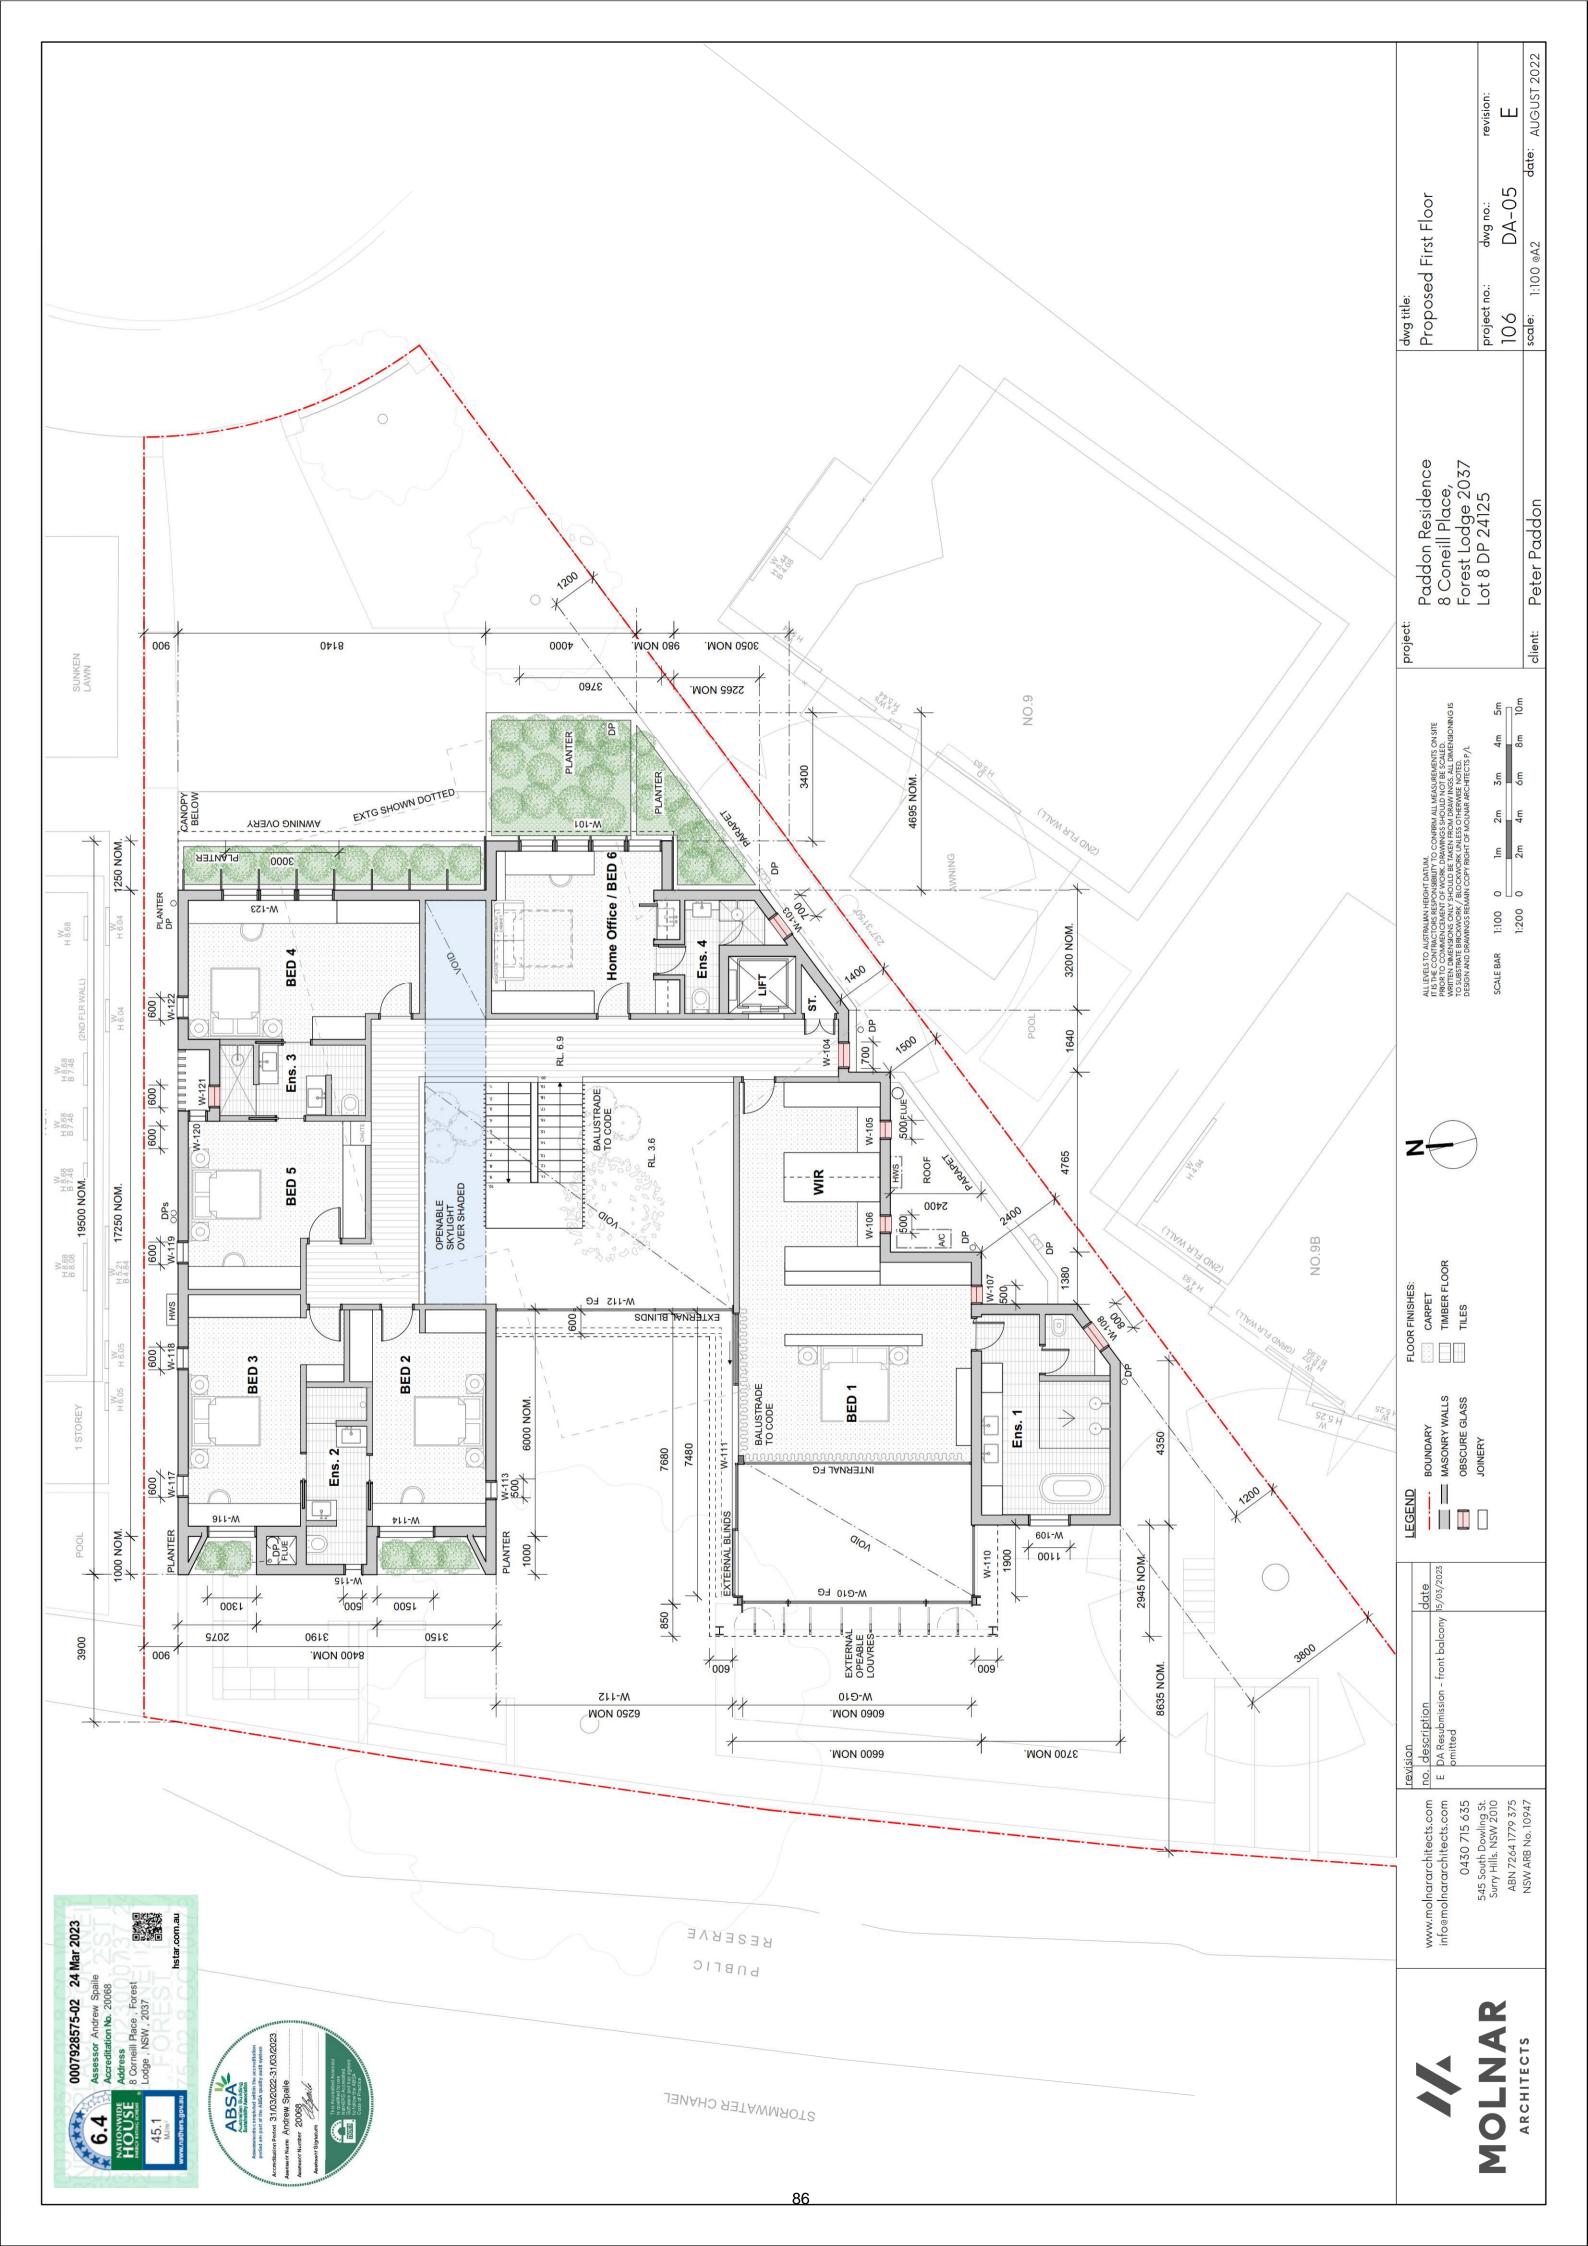


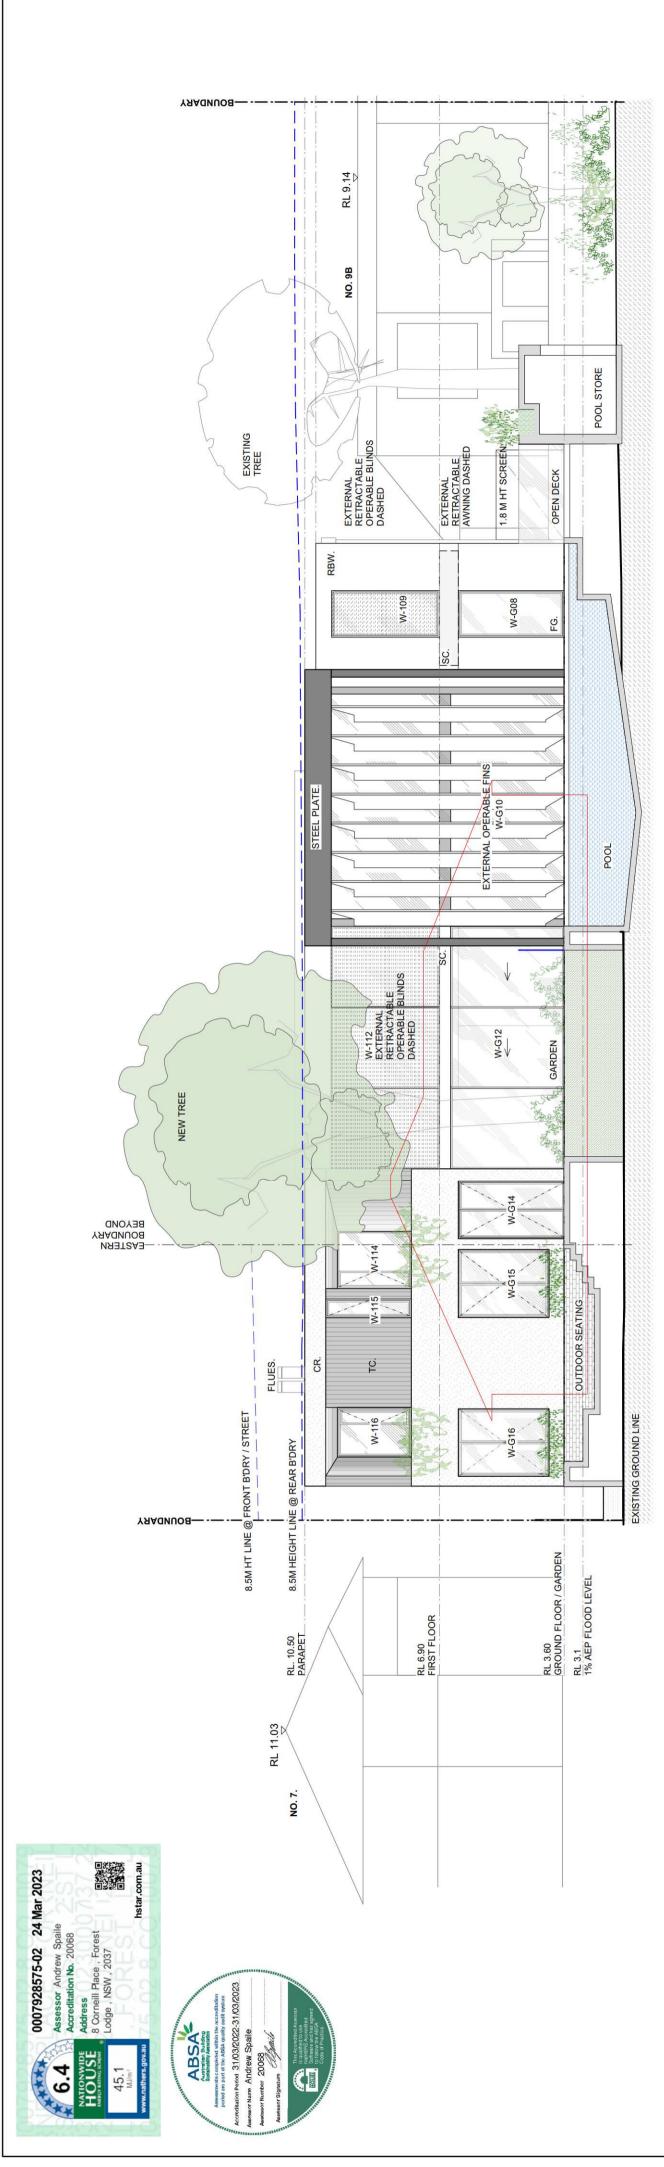
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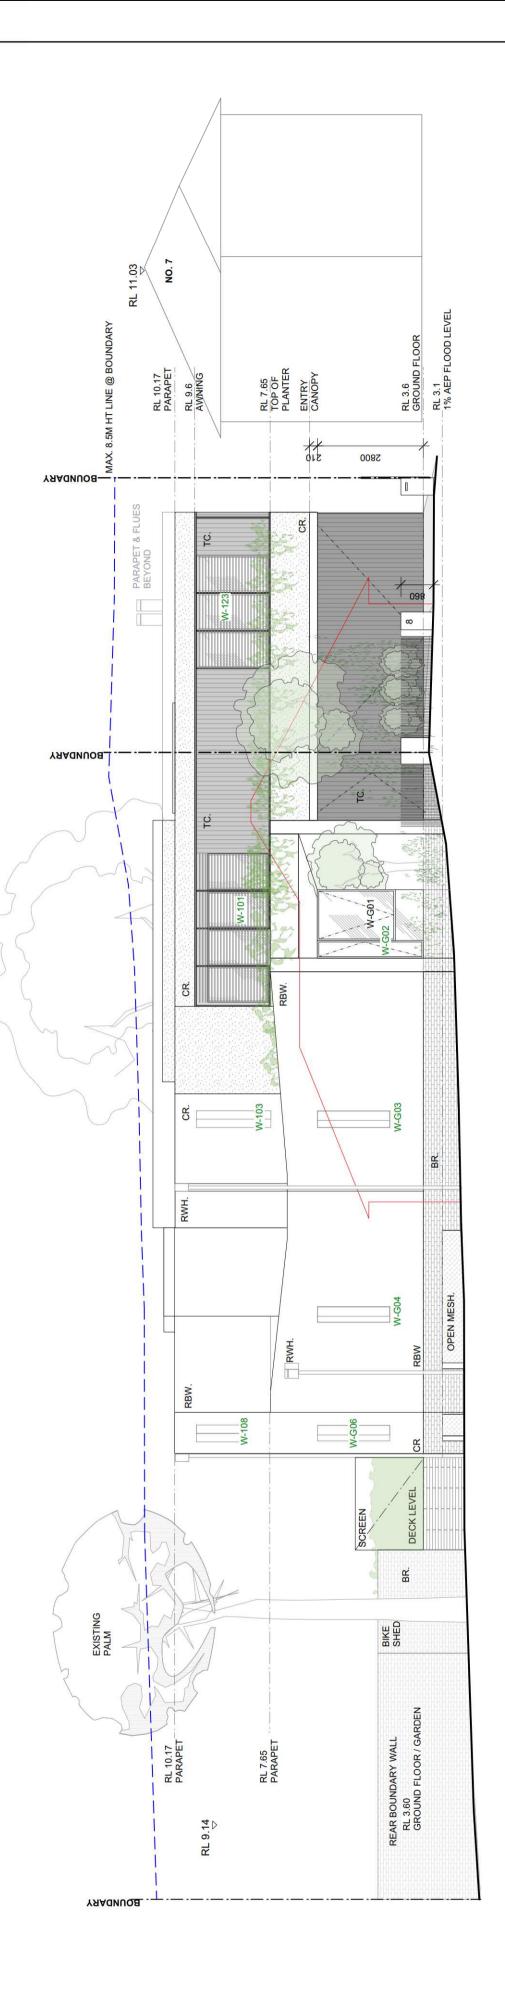






PROPOSED WEST ELEVATION

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PROPOSED EAST ELEVATION

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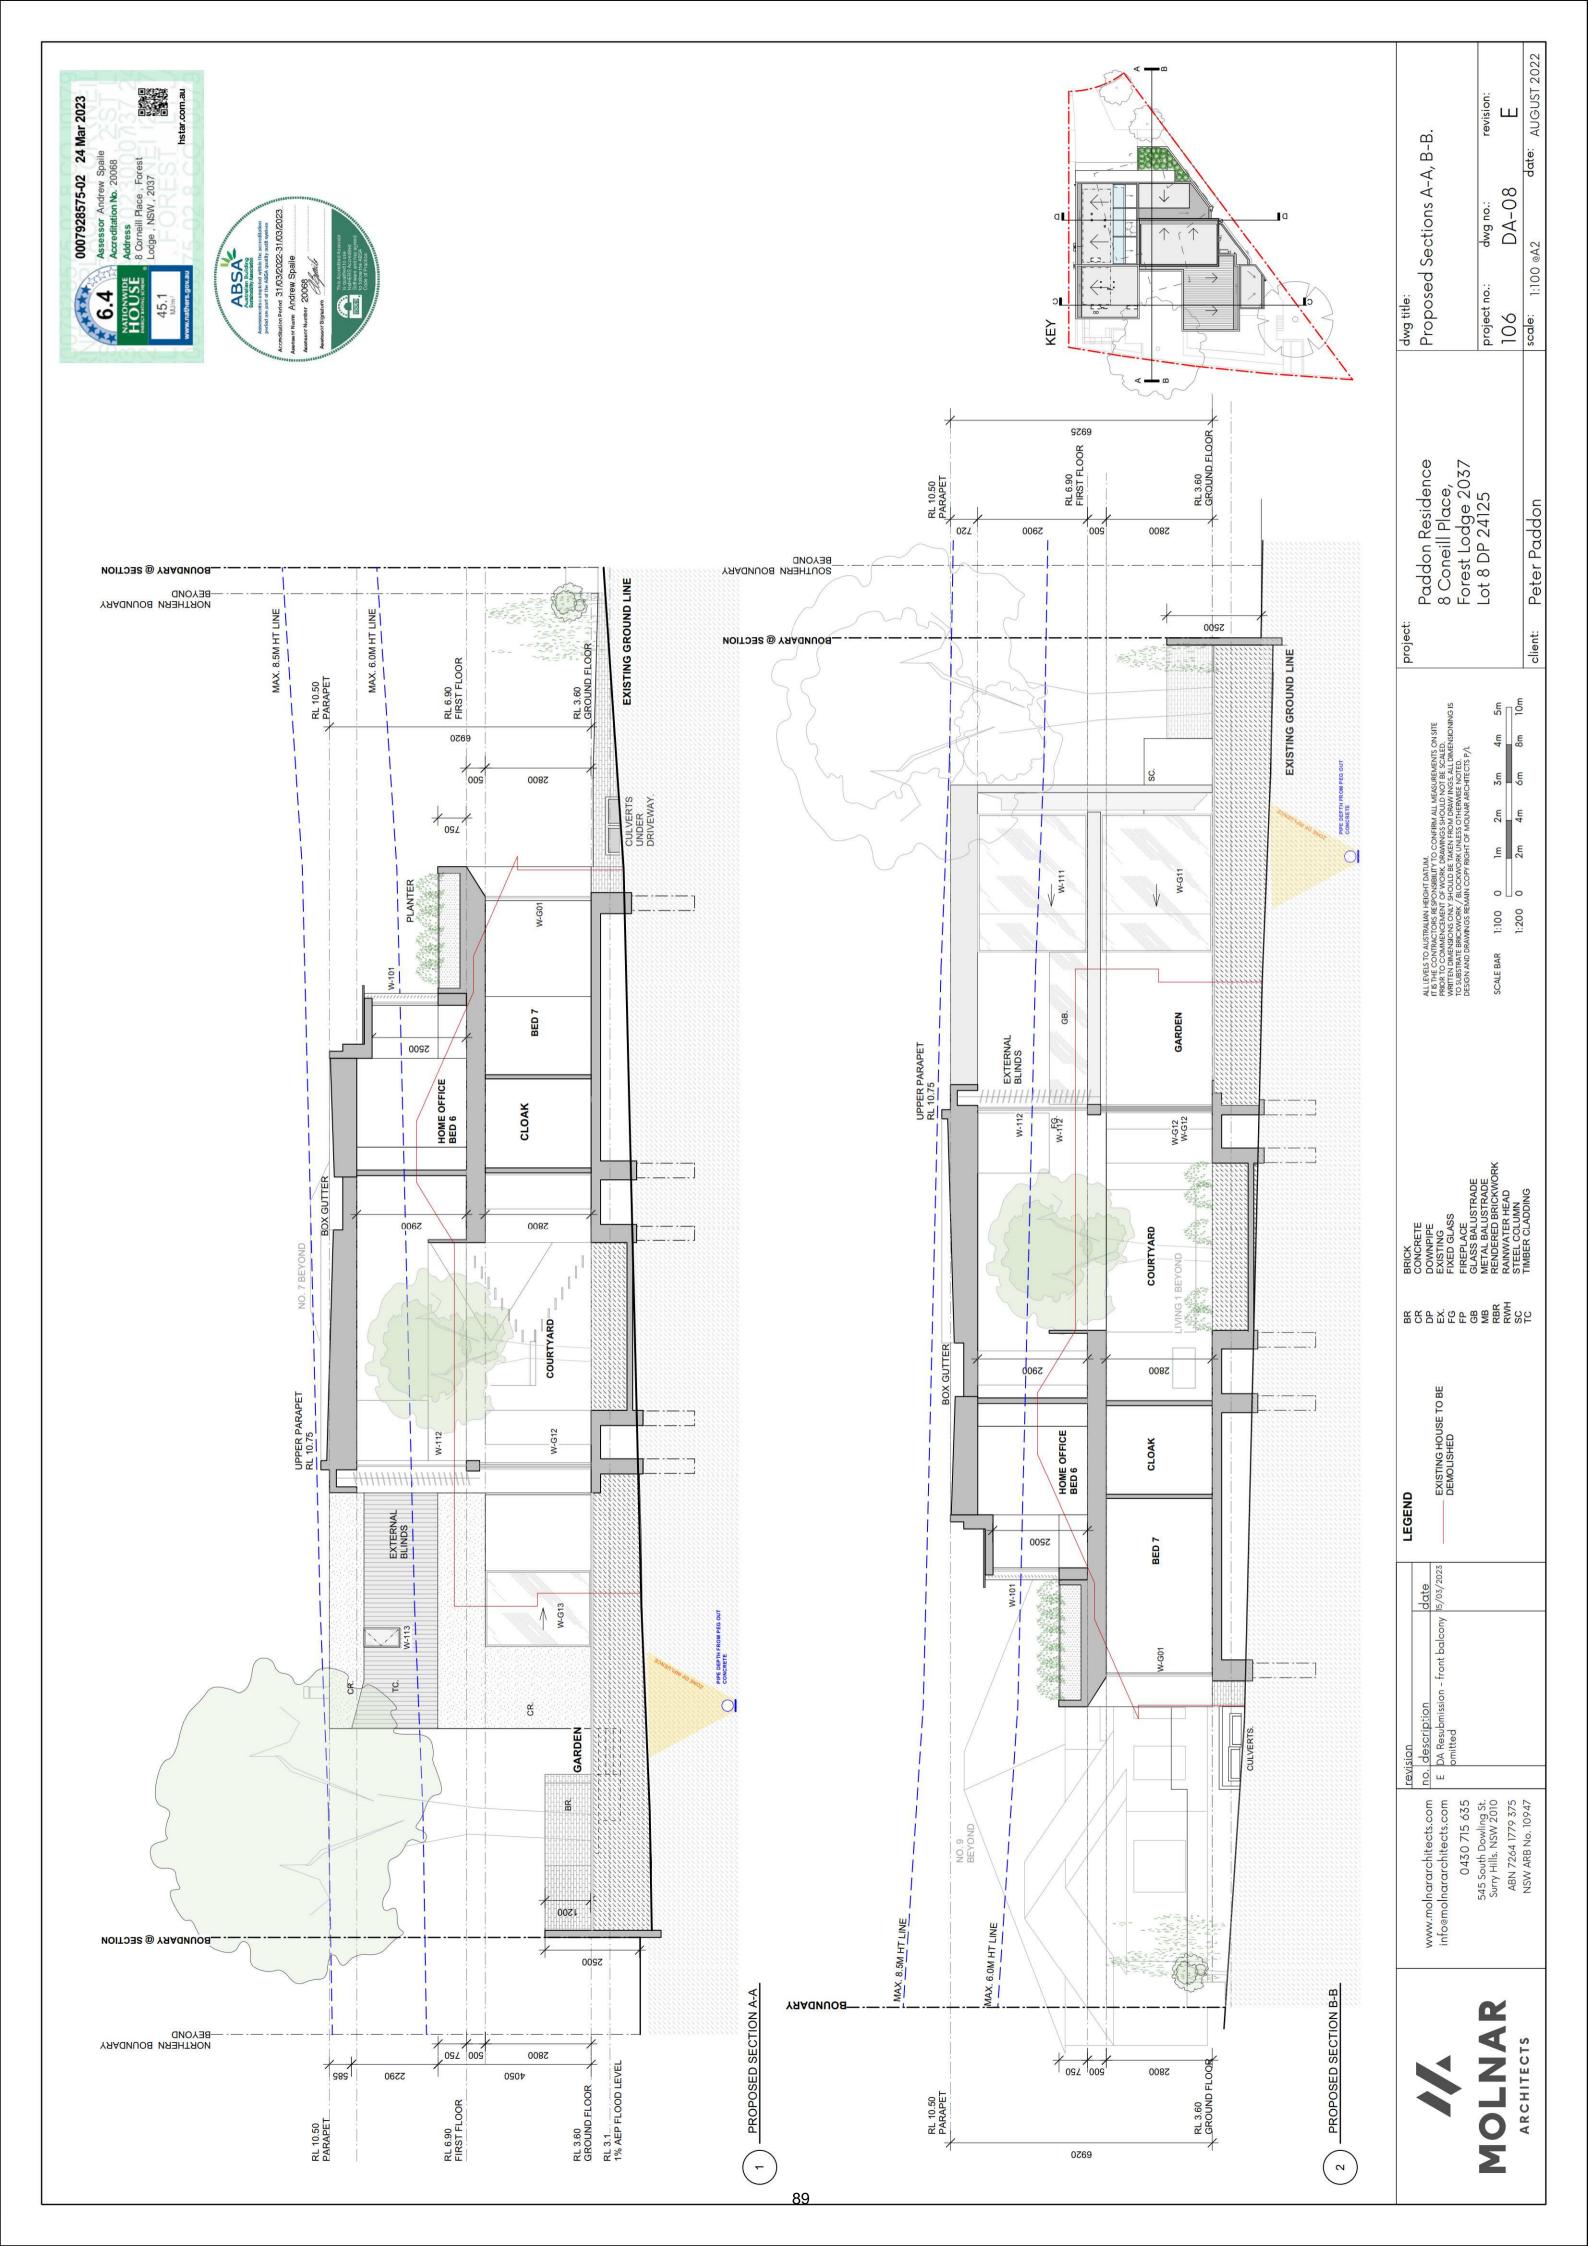
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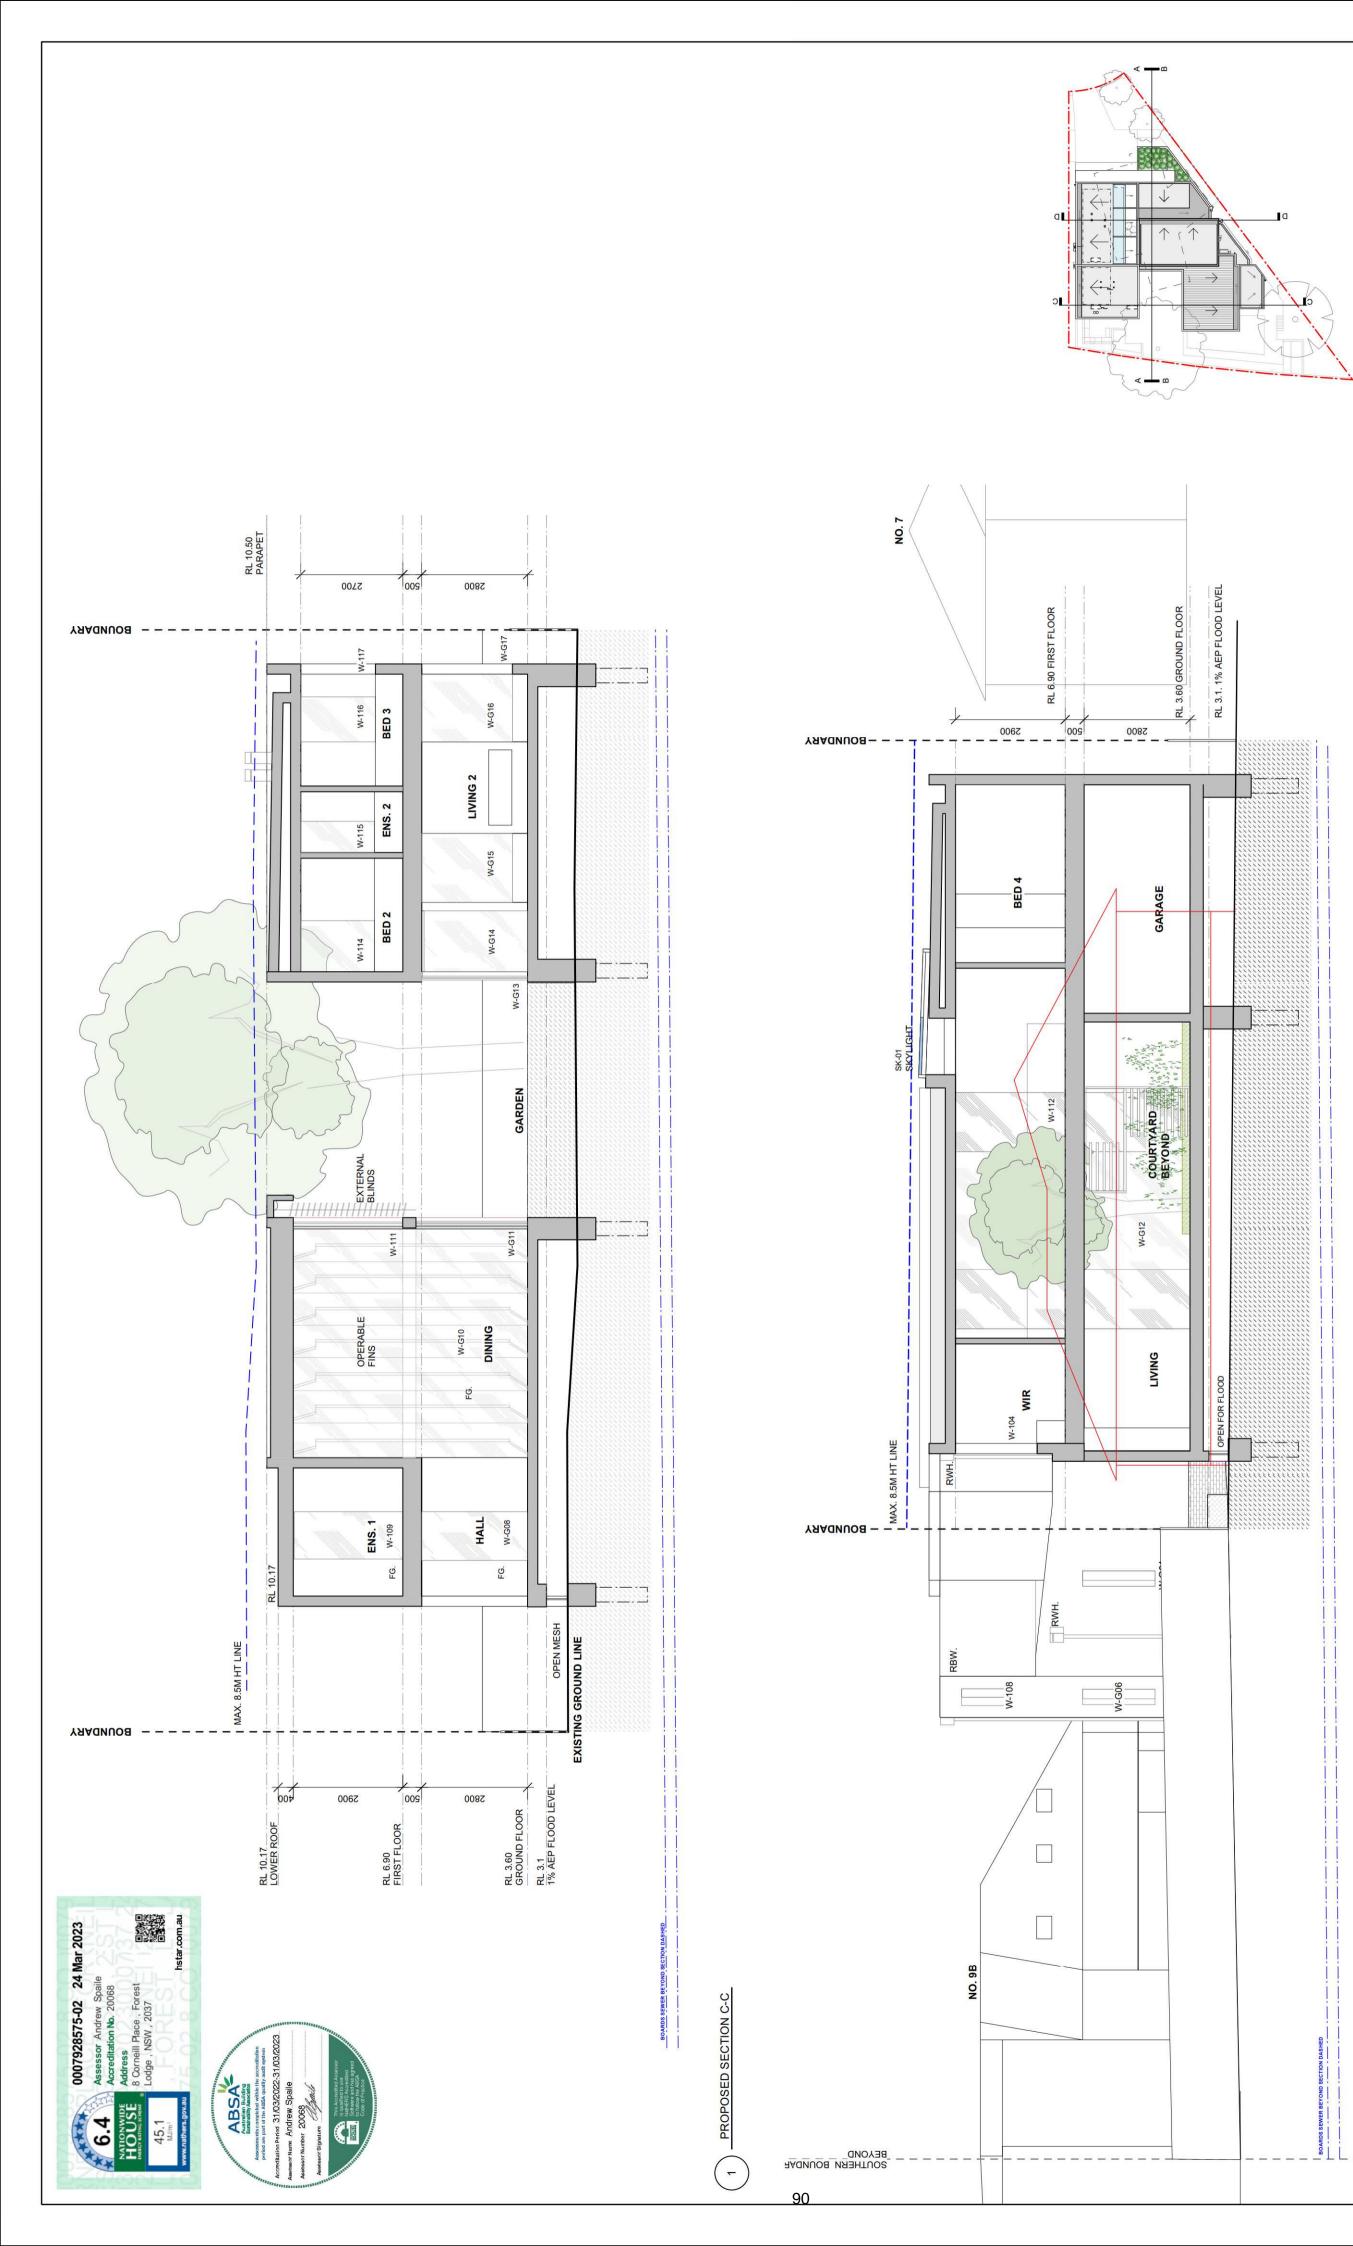
Paddon Residence 8 Coneill Place, Forest Lodge 2037 Lot 8 DP 24125

project:

dwg title: Proposed Elevations West and East Lot 8 DP 24125 revision: dwg no.: revision: 106 DA-06 E scale: 1:100 @A2 date: AUGUST 2022







date: AUGUST 2022

1:100 @A2

Peter Paddon

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EXISTING HOUSE TO BE DEMOLISHED

LEGEND

date 15/03/2023

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PROPOSED SECTION D-D

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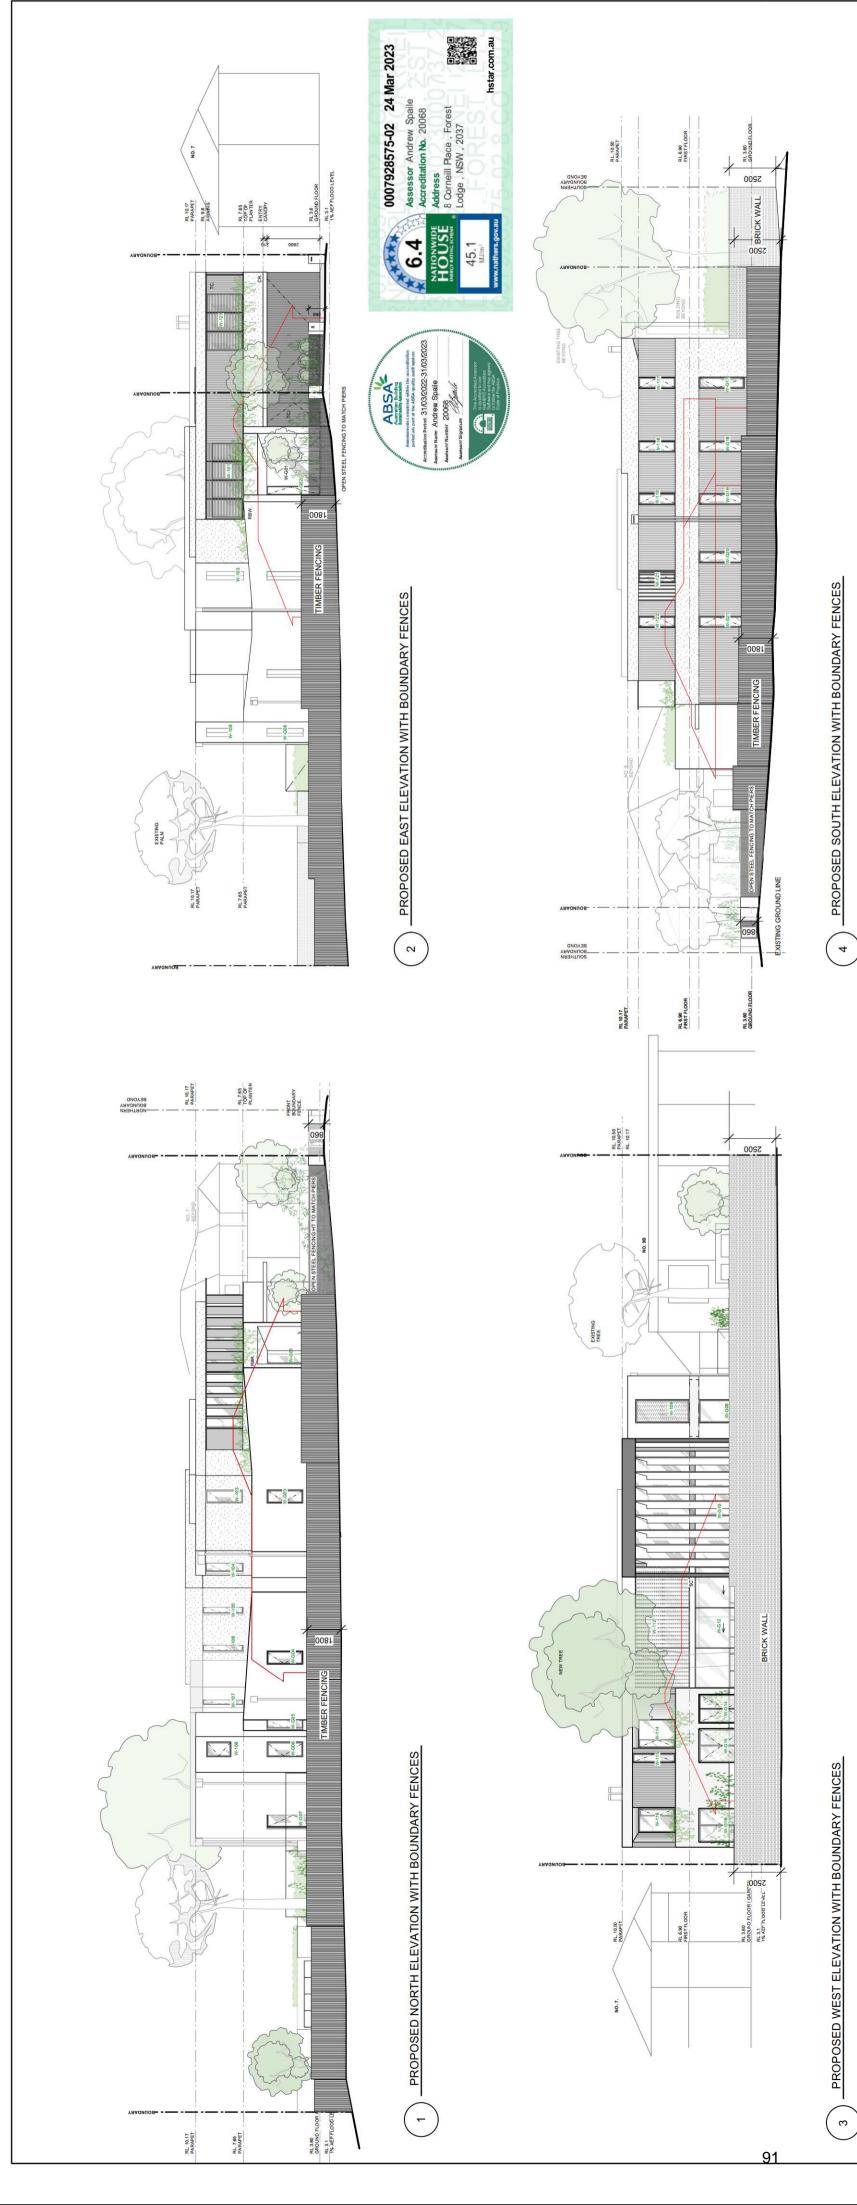
dwg no.: DA-09

project no.: 106 scale: 1:10

dwg title: Proposed Sections C-C, D-D

> Paddon Residence 8 Coneill Place, Forest Lodge 2037 Lot 8 DP 24125

project:



GROUND FLOOR:

						Oversiladowing			
Window No.	Type	Width (mm)	Height (mm)	Orientation	Area/ m2	Distance away /m	Height/m	Shading	Frame
W-G01	Awning	1340	2800	Ш	3.75	3	2	Eave 500mm 2 Storey	Aluminium
W-G02	Casement	480	2800	П 1	1.34 solid openable				Aluminium
W-G03	Casement	200	1900	S	1.33				Aluminium
W-G04	Casement	700	1900	S	1.33				Aluminium
W-G05	Casement	200	1900	S	0.95				Aluminium
W-G06	Casement	800	1900	S	1.52				Aluminium
W-G07	Casement	1000	2800	S	2.8	4	11		Aluminium
W-G08	Fixed	1100	2800	M	3.08			Retractable Awning 4 m Aluminium	Aluminium
W-G09	Fixed	2370	2800	S	6.64	4.5	3		Aluminium
W-G10	Fixed	0909	6160	M	37.3			External Operable Fins	Aluminium
W-G11	X 2 Slider	7950	2800	z	22.3	7.5	7		Aluminium
W-G12	Sliders	6250	2800	Μ	17.5	10	7	External Louvres	Aluminium
W-G13	Sliders	4800	2800	S	13.4				Aluminium
W-G14	Casement	1550	2800	Μ	4.3	8	7	Eave 600 mm	Aluminium
W-G15	Casement	1800	2400	M	4.32	5.5	7	Eave 600 mm	Aluminium
W-G16	Casement	1800	2400	M	4.32			Eave 600 mm	Aluminium
W-G17	Casement	009	2400	z	1.44				Aluminium
W-G18	Casement	009	2400	z	1.44				Aluminium
W-G19	Casement	009	2400	z	1.44				Aluminium
W-G20	Casement	009	2400	z	1.44				Aluminium
W-G20	Casement	009	2400	Z	1.44				Aluminium
W-G21	Casement	009	2400	Z	1.44				

Uw SHGC 5.4 0.41 2.3 0.50 3.2 0.46 Window Type Casement Fixed Sliding

WINDOW/DOOR THERMAL SPECIFICATION:

	W-G21	Casement	ent	009
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Frame	Aluminium	Aluminium	Aliminim
Shading	Eave 1200mm								External Louvres	Eave 600mm	Eave 600mm	Eave 600mm	Eave 450mm + external louvres	Eave 1000mm		Eave 1000mm							Fave 1250mm
Height/m											External louvres	External louvres	Eave 4										
Overshadowing	Distance away /m										7.5	10											
Area/ m2	6.4		2.0	1.5	1.0	1.0	1.4	1.0	3.6	6.9	23.5	18.3	0.5	2.9	1.1	2.5	1.2	1.2	1.2	6.0	1.2	1.2	5.9
Orientation	В		S	S	S	S	S	S	M	S	z	W	S	N	W	W	z	Z	z	Ш	z	z	ц
Height (mm)	1700		2900	2100	2100	2100	2800	1300	2900	2900	2900	2900	950	1950	2250	1950	1950	1950	1950	1950	1950	1950	1950
Width (mm)	3760		700	700	200	200	200	800	1250	2370	8100	6300	200	1500	200	1300	009	009	009	200	009	009	3000
Type	Casement		Casement	Casement	Casement	Casement	Casement	Casement	Fixed	Fixed	Fixed & Slider	Fixed	Casement	Casement	Casement	Casement	Casement	Casement	Casement	Casement	Casement	Casement	Casement
Window No.	W-101		W-103	W-104	W-105	W-106	W-107	W-108	W-109	W-110	W-111	W-112	W-113	W-114	W-115	W-116	W-117	W-118	W-119	W-120	W-121	W-122	W-123

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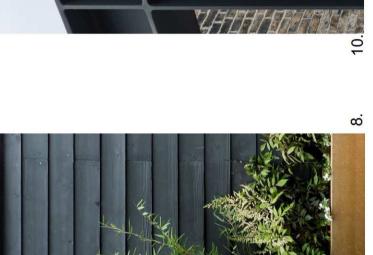
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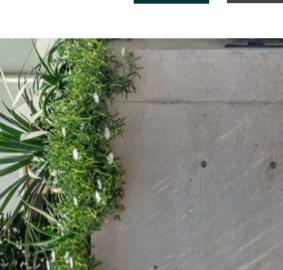






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2. METAL THIN PROFILE WINDOW/ DOOR FRAMES

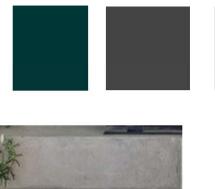
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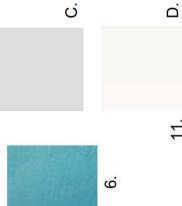
4. EXTERNAL OPERABLE VERTICAL FINS

3. RECYCLED BRICKWORK



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A: DEEP GREEN METALLIC STEEL B: DEEP GRAPHITE METALLIC STEEL C: CONCRETE GREY D: WHITE RENDER

10. EXPRESSED DARK COLOURED STEEL

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